
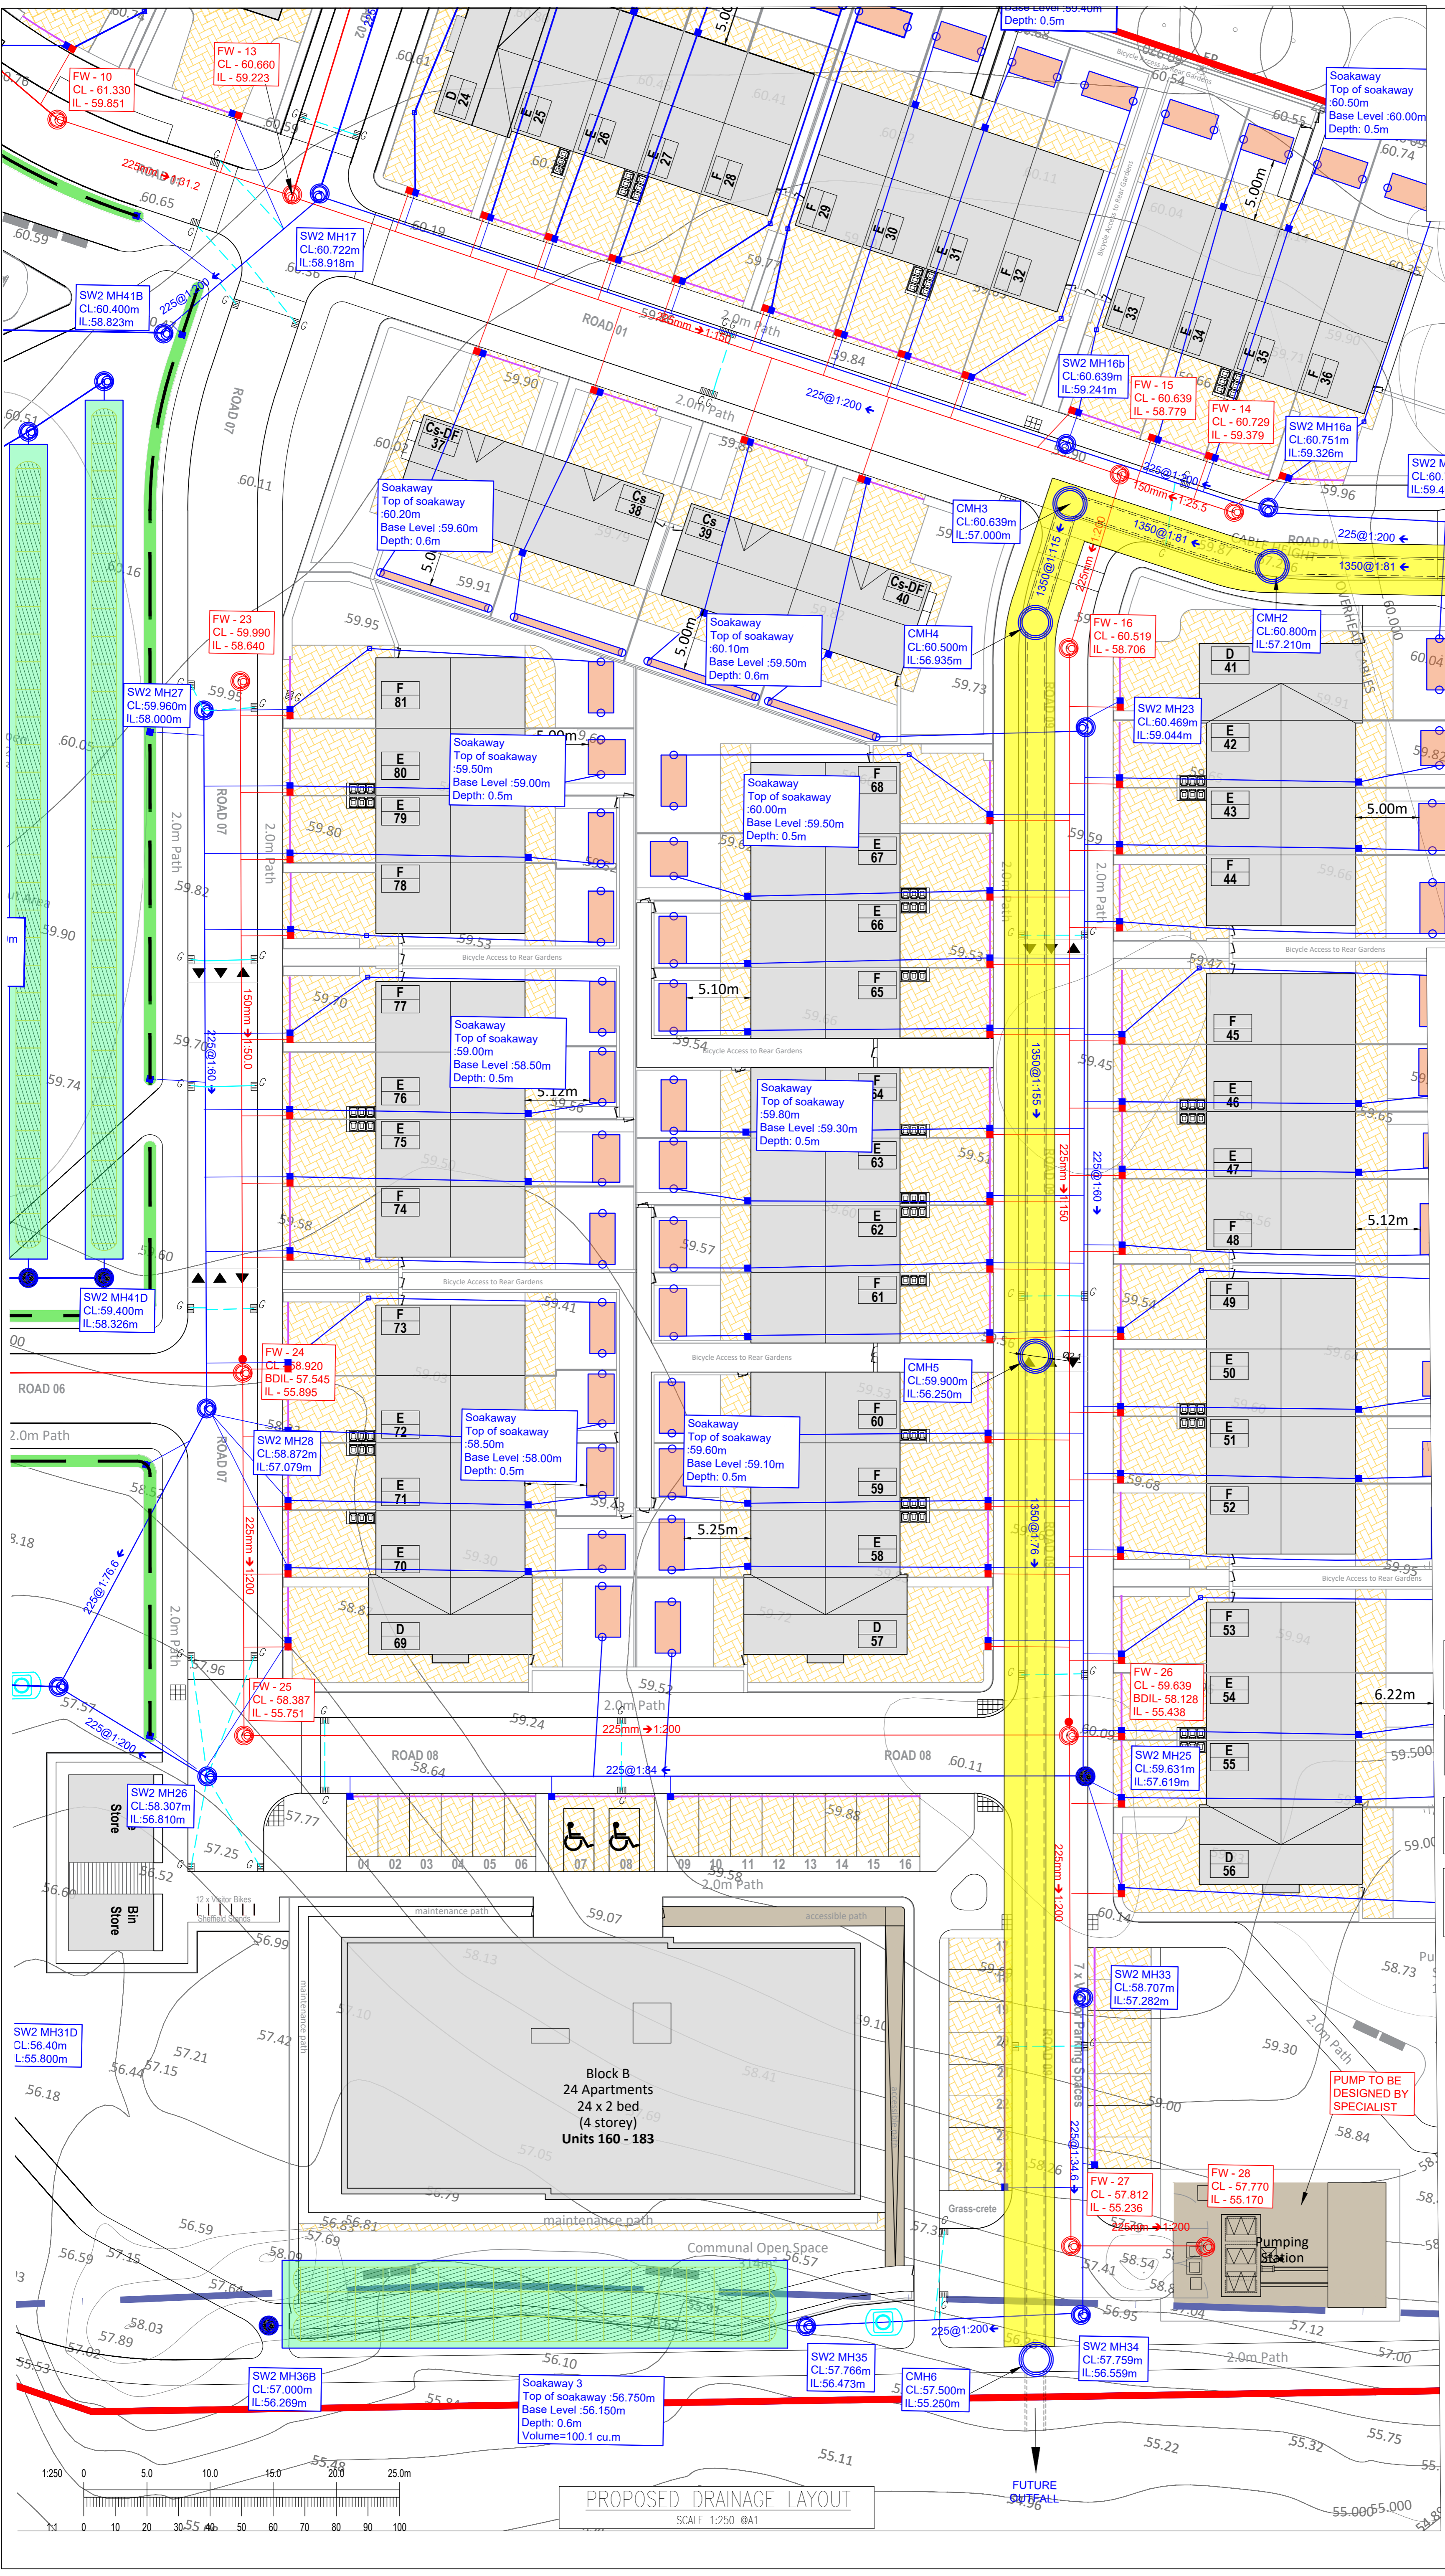


This drawing should not be scaled. Dimensions to be verified on site. Any discrepancies should be referred to the Engineer prior to work being put in hand. This drawing is the property of Waterman Moylan Consulting Engineers Limited and is issued on the condition that it is not copied, reproduced, retained or disclosed to any unauthorized person, either wholly or in part without the consent in writing of Waterman Moylan Consulting Engineers Limited. Block 5, East Point Business Park, Dublin D03 H3F4 Ireland. T: 01 664 8900. E: info@waterman-moylan.ie

- NOTES:
- DO NOT SCALE. USE FIGURED DIMENSIONS ONLY.
 - THIS DRAWING IS TO BE READ IN CONJUNCTION WITH ALL OTHER RELEVANT ARCHITECTURAL AND ENGINEERING DRAWINGS.

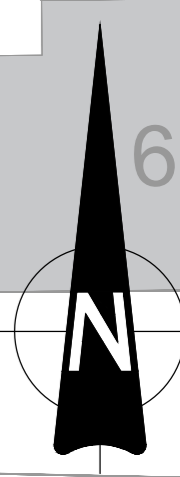

LEGEND

- EXTENT OF WORKS
- PROPOSED UPVC FOUL WATER SEWER WITH PIPE SIZE, GRADE, MANHOLE REF. AND INVERT LEVEL
- PROPOSED SURFACE WATER SEWER WITH PIPE SIZE, GRADE, MANHOLE REF. AND INVERT LEVEL
- INDICATES PROPOSED ROAD GULLY AND CONNECTION
- INDICATES PROPOSED PERMEABLE PAVING
- PROPOSED STORM WATER HOUSE DRAIN AND ACCESS CHAMBER
- PROPOSED FOUL WATER HOUSE DRAIN AND ACCESS CHAMBER
- PROPOSED SWALE WATER ACCESS CHAMBER & CONNECTION
- PROPOSED SOAKAWAY WITH STORMTECH
- PROPOSED SOAKAWAY WITH STONE
- PROPOSED SURFACE WATER SEWER WITH PIPE SIZE, GRADE, MANHOLE REF. AND INVERT LEVEL (CONCRETE SURROUND)
- INDICATES PROPOSED 1.35m DIA SWS PIPE (BY OTHERS)
- INDICATES 4.0m WAYLEAVE FOR 1.35m DIA SWS PIPE (BY OTHERS)
- INDICATES NSR003 PETROL INTERCEPTOR

- NOTE: CONTRACTOR TO CONFIRM POSITION AND INVERT OF ALL EXISTING SERVICES PRIOR TO COMMENCEMENT OF ANY WORKS. CONTRACTOR TO IMMEDIATELY INFORM ENGINEER IF ANY DISCREPANCIES ARE IDENTIFIED.
- NOTE: FOR DETAILS OF INSTALLATION PLEASE REFER TO IRISH WATERS 'CODE OF PRACTICE FOR WASTEWATER INFRASTRUCTURE' & 'WASTEWATER INFRASTRUCTURE STANDARD DETAILS'
- NOTE: PUBLIC FOUL PIPE MATERIAL TO BE U-PVC (STIFFNESS CLASS 8) AND IN COMPLIANCE WITH SECTION 3.13 OF IRISH WATER CODE OF PRACTICE.
- NOTE: FOUL SEWERS TO BE CONSTRUCTED WITH CONCRETE SURROUND IN ACCORDANCE WITH IRISH WATER STD-WW-08 WHERE VERTICAL CLEARANCE FROM SURFACE WATER IS LESS THAN 300mm AND WHERE DEPTH OF COVER TO ROAD IS LESS THAN 1.2m

Rev	Date	Description	By	Chk

Project: **KILDALKEY ROAD, TRIM, CO. MEATH**


Title: **PROPOSED FUTURE CULVERT**

Client: **LOUGHLYNN DEVELOPMENTS LIMITED**

Block 5, Eastpoint Business Park, Alfie Byrne Road, Dublin D03 H3F4 Ireland. Tel: (01) 664 8900. Email: info@waterman-moylan.ie www.waterman-moylan.ie

Status: **FOR PLANNING**

Designed By: BG	Approved: Waterman Ref: 23-041
Drawn By: GB	Date: JUNE, 2026
Project: TRIM - WAT - ZZ - XX - DR - C - P501	Scale: AS SHOWN

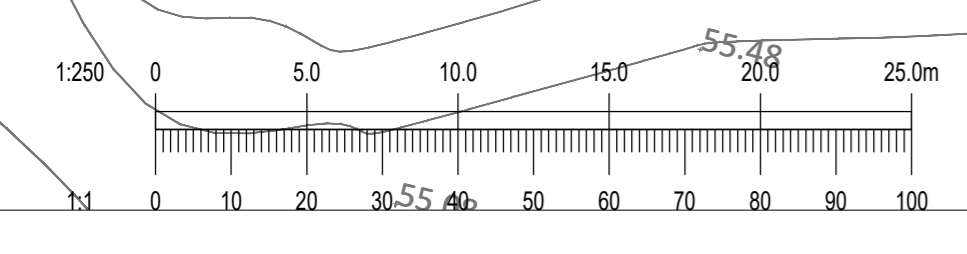

PROPOSED DRAINAGE LAYOUT
SCALE 1:250 @A1

Drawing Location: N:\Projects\2023-04-11 Trim Co Meath\Drawings\Waterman Moylan\Civil\Planning\Autocad\Drawings\23-04-11-P501 - Proposed Future Culvert.dwg
Date: Jun 16, 2026 - 2:42pm